



ELECTRICAL NOTE:  
SEE SITE PLAN OF ELECTRICAL DIST.  
REDUCTION FOR SERVICE DROPS TO EACH  
BUILDING AND POINT OF ATTACHMENT.

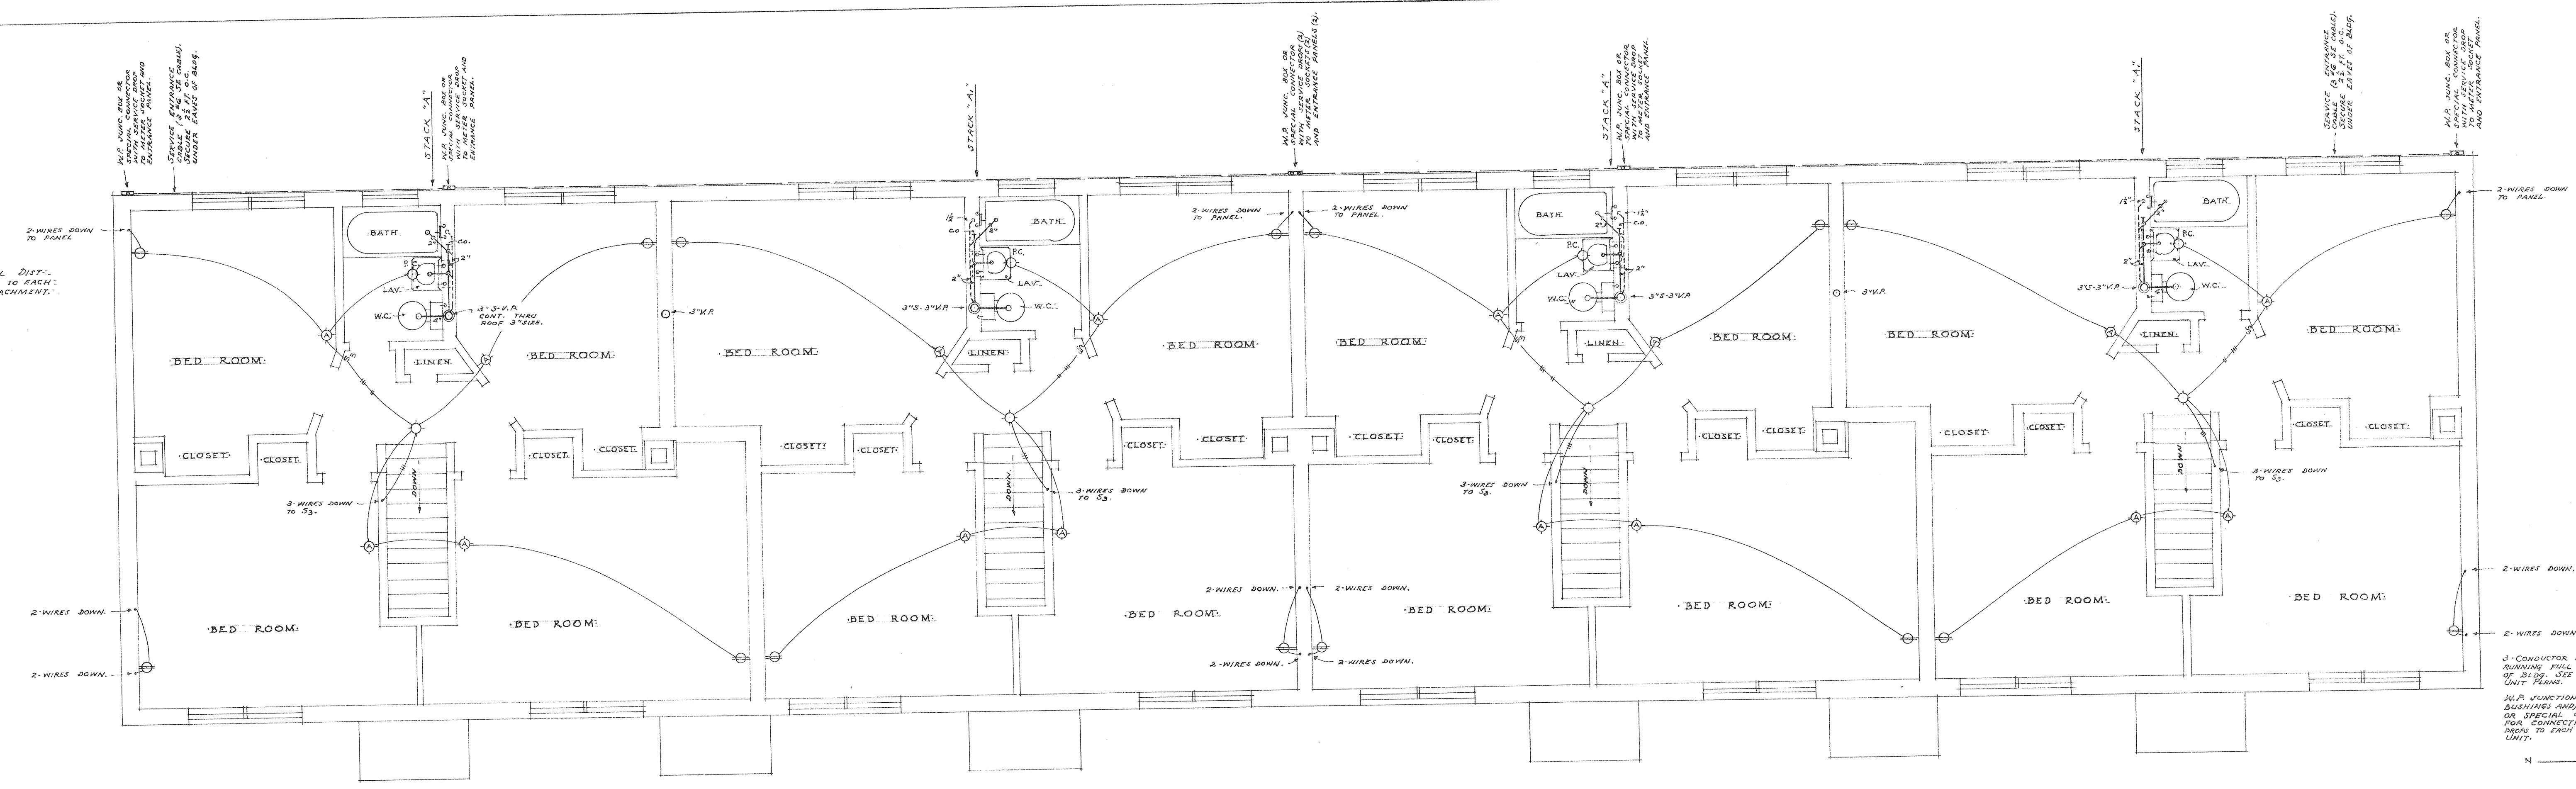

SECOND FLOOR PLAN  
SCALE: 1/4" = 1'-0"

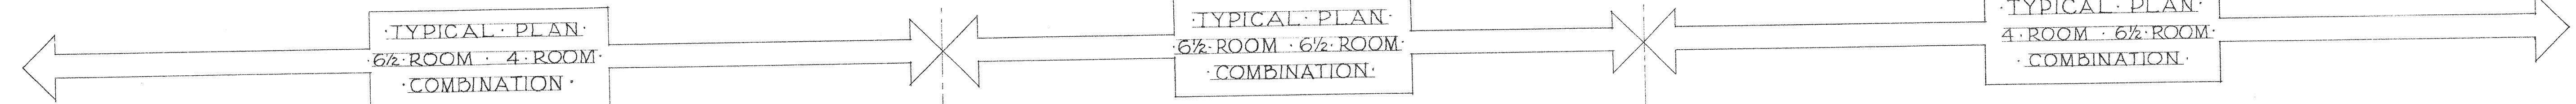


3-CONDUCTOR SE CABLE  
DURING FULL LENGTH  
OF BLDG. SEE DETAIL  
UNIT PLAN.

ALL JUNCTION BOX WITH  
BUSINESS AND/OR ADJUSTABLE  
OR SPECIAL CONNECTIONS  
FOR CONNECTION TO SERVICE  
DROPS TO EACH DWELLING UNIT.

3-CONDUCTOR SE CABLE  
SERVICE DROP TO EACH  
DWELLING UNIT.

SECURE ALL SE CABLE  
WITH APPROVED CLAMPS  
24" P.C. (MAX).

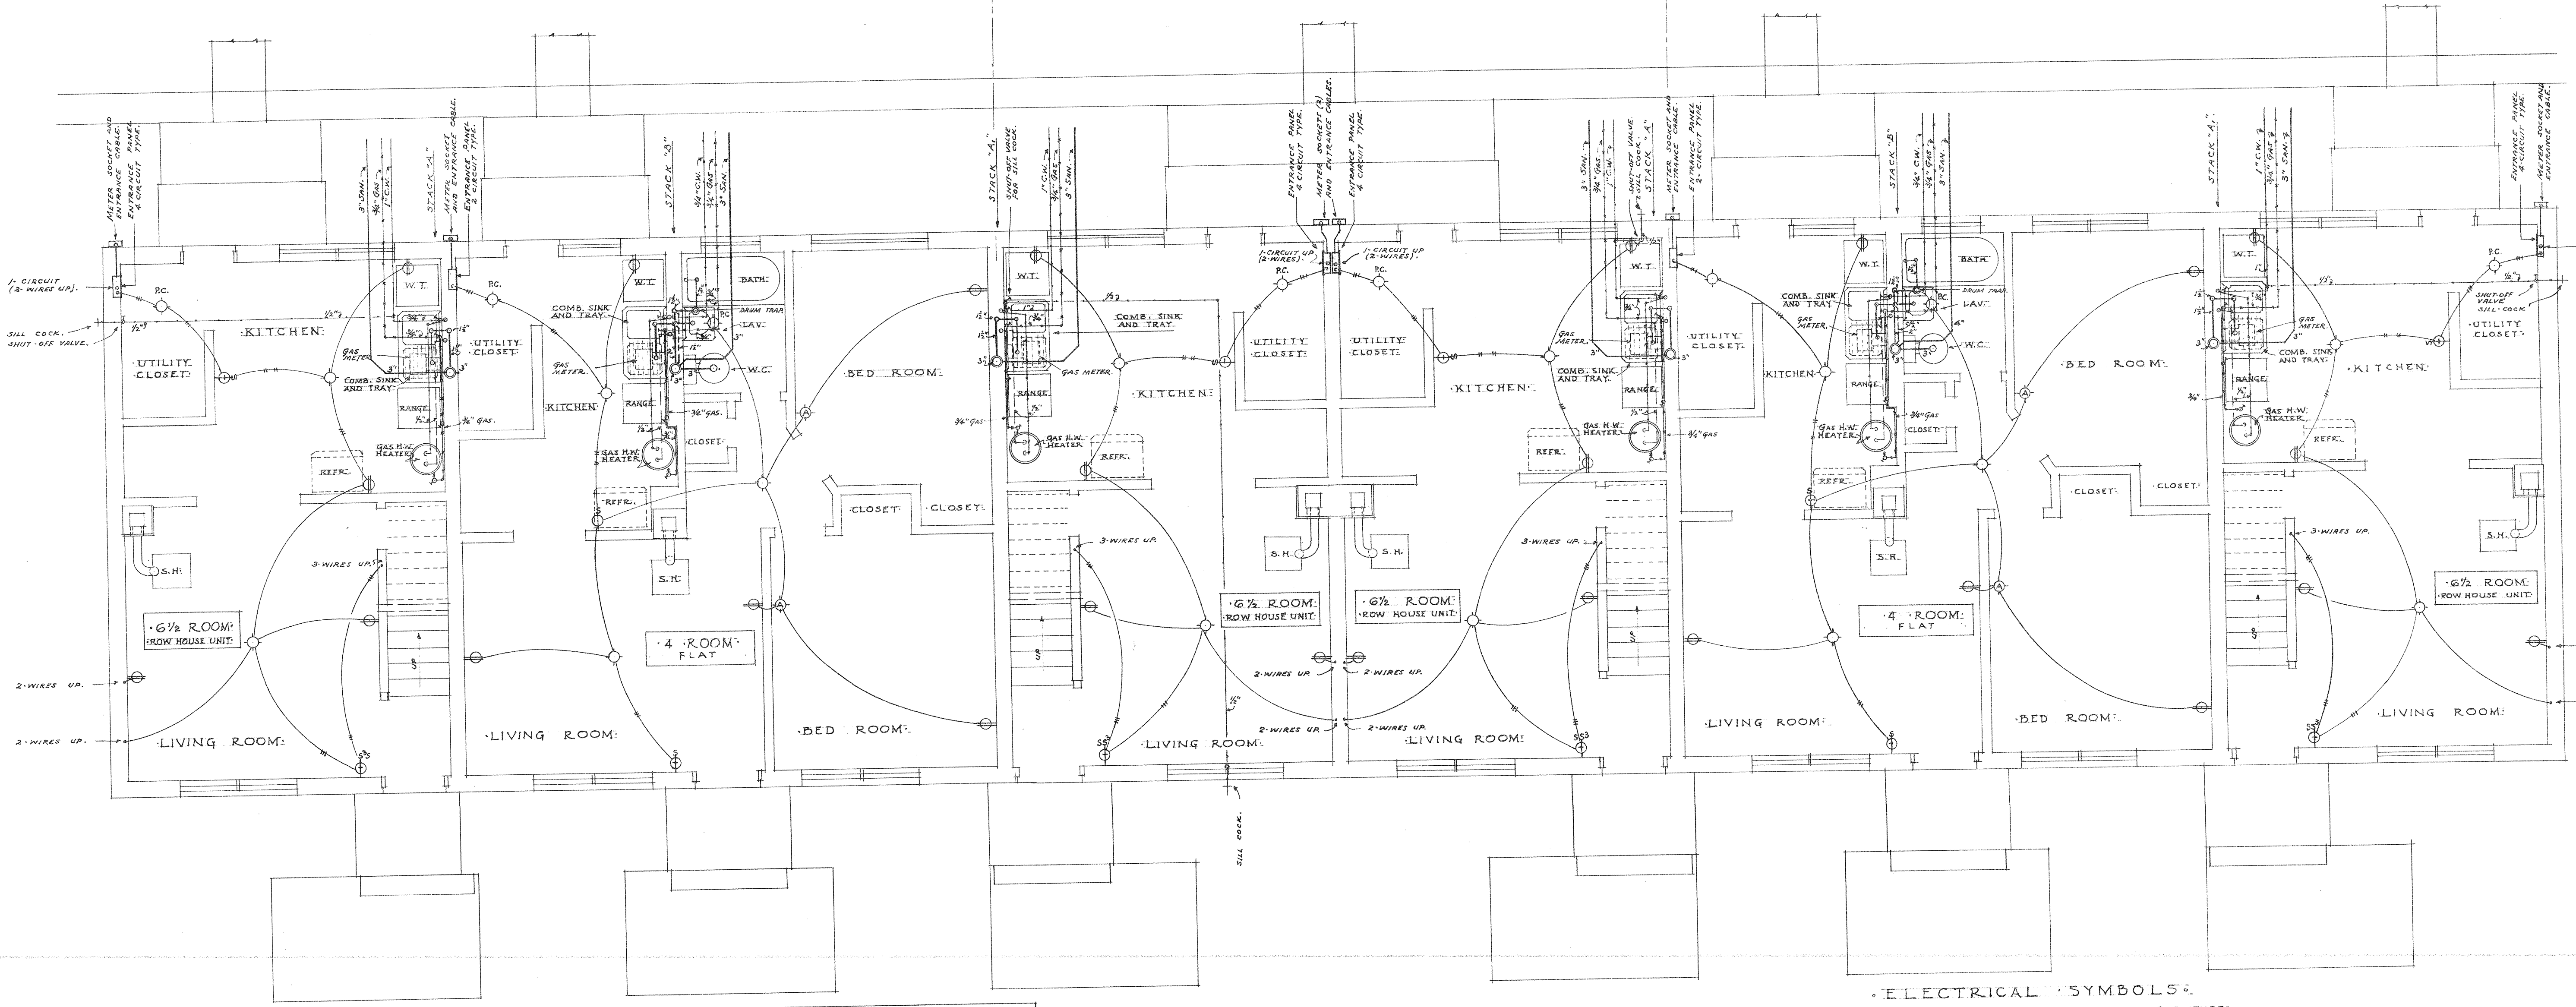

FIRST FLOOR PLAN  
SCALE: 1/4" = 1'-0"

SCHEDULE OF FIXTURE CONNECTIONS


TYPE	H.W.	G.W.	TRAP	GAS	REMARKS
WATER CLOSERS		3/8"	INTER.		
LAVATORIES	3/8"	3/8"	1/2"		DRUM TRAPS FIRST FLOOR
BATHS	1/2"	1/2"	1/2"		CONT. WASTE
COMBINATION SINK AND TRAY	1/2"	1/2"	1/2"		
RANGE				3/4"	
H.W. HEATER	1/2"	1/2"		3/4"	
SPACE HEATERS					BLUE CONNECTIONS

NOTE: RANGES, H.W. HEATERS & SPACE HEATERS WILL  
BE FURNISHED BY OTHERS. SEE SPEC.

- ELECTRICAL SYMBOLS:
- ⊙ CEILING FIXTURE. SEE SPEC. FOR TYPE OF FIXTURE.
  - ⊙ BRACKET FIXTURE WITH PULL CORD SWITCH.
  - ⊙ BRACKET FIXTURE WITH LAMP HOLDER, TOGGLE CONTROL  
SWITCH AND SINGLE INSERTION RECEPTACLE. (5'0" MOUNTING HEIGHT).
  - ⊙ COMBINATION TOGGLE SWITCH AND INSERTION RECEPTACLE.  
(4'0" MOUNTING HEIGHT.)
  - ⊙ DUPLEX INSERTION RECEPTACLE. (12" MOUNTING HEIGHT EXCEPT  
IN KITCHEN WHICH SHALL BE 4'0" OR 4'8" HEIGHT.)
  - ⊙ SINGLE POLE TOGGLE WALL SWITCH. (4'0" MOUNTING HEIGHT.)
  - ⊙ THREE WAY TOGGLE WALL SWITCH.
  - ⊙ COMBINATION INSERTION RECEPTACLE AND SINGLE & THREE  
WAY TOGGLE SWITCHES.
  - WP WEATHER - PROOF.

SECTION SHOWING TYPICAL  
ELECTRIC SERVICE CONNECTIONS  
TO EACH BUILDING AND D.U.  
SCALE: 1/4" = 1'-0"

NOTE: SEE 3/4" SCALE DETAILED DRAWINGS  
SHOWING TYPICAL PLYING DETAIL OF 6 1/2 AND  
4 1/2 ROOM ROW HOUSE UNITS.

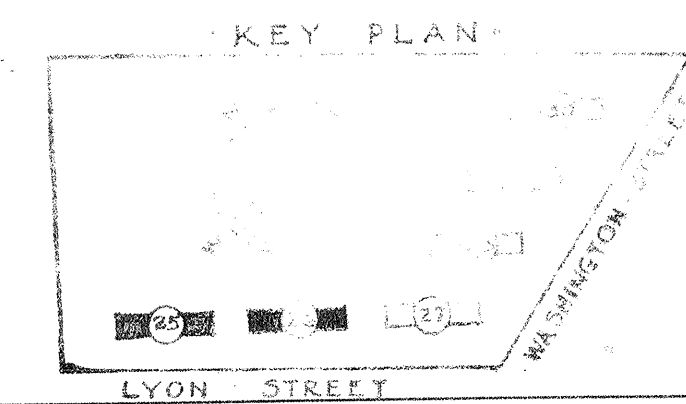

DETAIL UNIT PLANS  
BUILDINGS 25-26

GONZALES GARDENS EXTENSION  
LOW RENT HOUSING PROJECT COLUMBIA, SC-2-1A

THE HOUSING AUTHORITY OF THE CITY OF COLUMBIA, S.C.

DESIGNED BY  
JAMES POSEY CONSULTING ENGINEERS

DATE 3-27-65

SCALE: 1/4" = 1'-0"

SHEET NO. 601